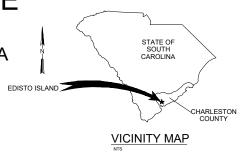
FOR ILLUSTRATIVE PURPOSES ONLY

EXAMPLE LIVING SHORELINE REEF PROJECT

CHARLESTON COUNTY, SOUTH CAROLINA



EXAMPLE LIVING SHORELINE REEF PROJECT LOCATION

LOCATION MAP

AFFECTED PARCELS:

LAT AND LONG: DIRECTIONS:

DRAWING COURTESY OF THE NATURE **CONSERVANCY AND JACOBS SOLUTIONS**

PROJECT INFORMATION: APPLICATION NUMBER: PROJECT ADDRESS:

COUNTY: ACTIVITY: DATE: APPLICANT:

CONTACT INFORMATION:

AGENT:

DESIGNER:

INDEX OF DRAWINGS

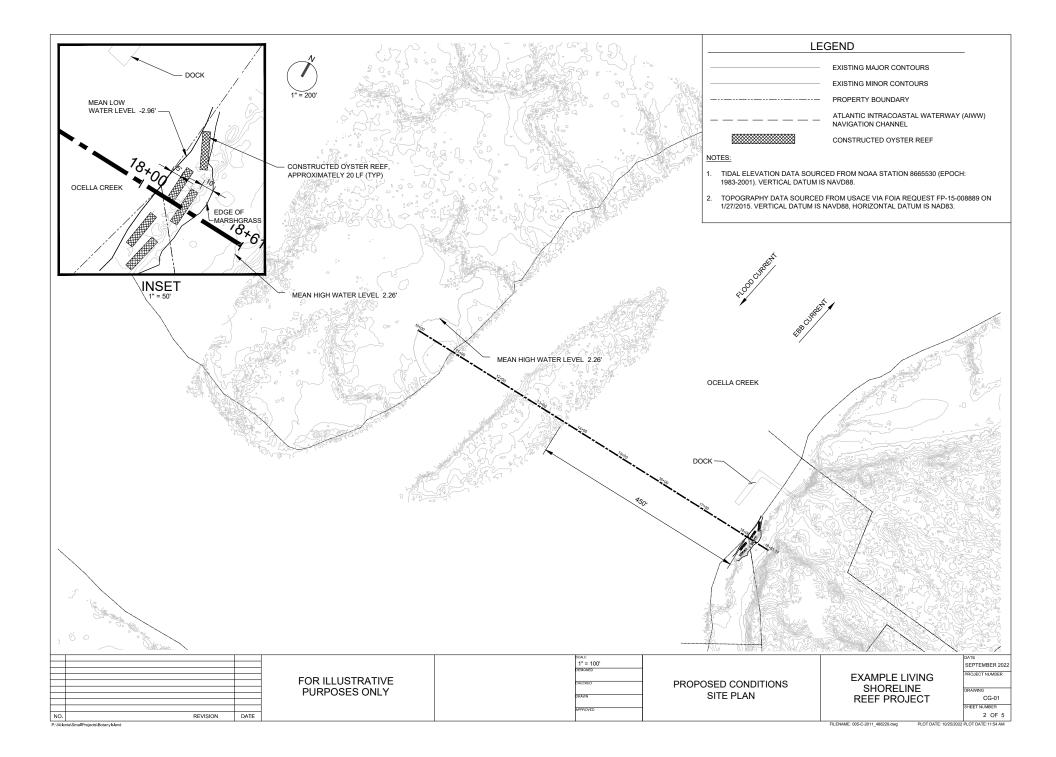
G-01 CG-01 CD-01 TITLE SHEET, VICINITY MAP AND LOCATION MAP PROPOSED CONDITIONS SITE PLAN

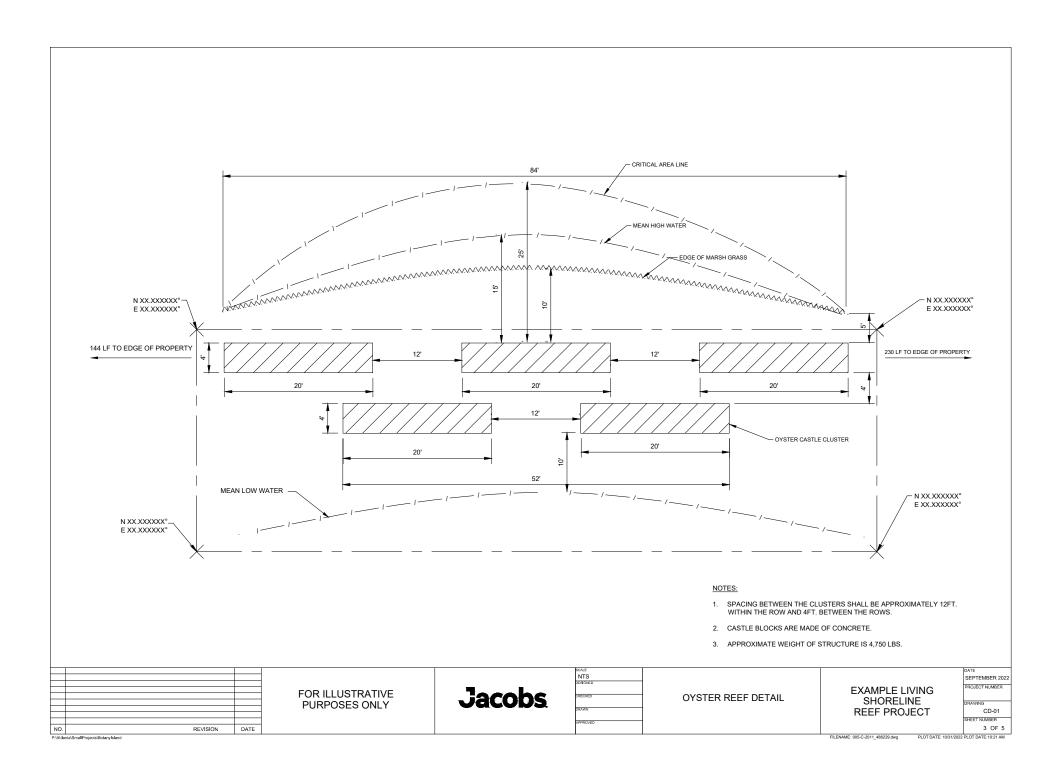
OYSTER REEF DETAIL

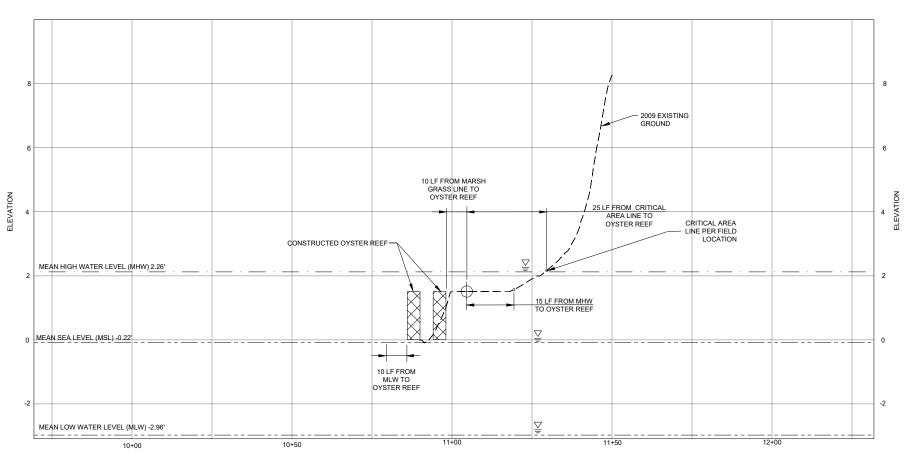
CP-01 SITE PROFILE

OYSTER REEF DETAIL

NO	. REVISION DATE	FOR ILLUSTRATIVE PURPOSES ONLY	DOALE NTS CERORED CHECKED CRAWN APPROVED	TITLE SHEET, VICINITY MAP AND LOCATION MAP	EXAMPLE LIVING SHORELINE REEF PROJECT	DATE SEPTEMBER 2022 PROJECT NUMBER DRAWING G-01 SHEET NUMBER 1 OF 5
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NOTES:

 TIDAL ELEVATION DATA SOURCED FROM NOAA STATION 8665530 (EPOCH: 1983-2001). VERTICAL DATUM IS NAVD88.

 TOPOGRAPHY DATA SOURCED FROM 2009 SOUTH CAROLINA DEPARTMENT OF NATURAL RESOURCES LIDAR OF CHARLESTON COUNTY, AVAILABLE FROM NOAA DIGITAL COAST DATA REQUEST 242736 ON 11/16/17. HORIZONTAL DATUM NADB3, VERTICAL DATUM NAVD88. SITE PROFILE
SCALE: 1" = 30' (HOR)
SCALE: 1" = 2.5' (VERT)

FOR ILLUSTRATIVE PURPOSES ONLY

FOR ILLUSTRATIVE PURPOSES ONLY

FOR ILLUSTRATIVE PURPOSES ONLY

SITE PROFILE

EXAMPLE LIVING SHORELINE SHOWN

SHORELINE REEF PROJECT

OP-01

SHEET NUMBER

OP-01

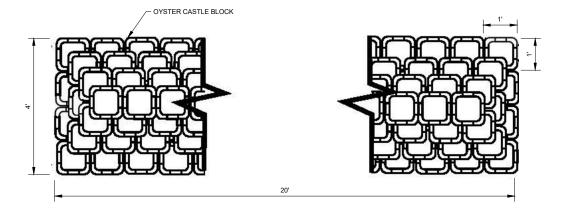
SHEET NUMBER

FLEMME: 005-02011, Profite days

FLEMME: 005-02011, Profite days

FLEMME: 005-02011, Profite days

PLOT DATE: 1051 AND THE: 1051 A



OYSTER CASTLE BLOCK

OYSTER CASTLE BLOCK

EXISTING GRADE

PLAN VIEW

SIDE VIEW

NOTES:

- SPACING BETWEEN THE CLUSTERS SHALL BE APPROXIMATELY 12FT.
 WITHIN THE ROW AND 4FT. BETWEEN THE ROWS.
- 2. CASTLE BLOCKS ARE MADE OF CONCRETE.
- 3. APPROXIMATE WEIGHT OF STRUCTURE IS 4,750 LBS.
- 4. APPROXIMATE 190 OYSTER CASTLE BLOCKS PER CLUSTER.

P.W.lantial/Small Projects/Bolandsband PLOT DATE: 10/26/2022 PLOT DATE: 8:36 AM	NO.	REVISION	DATE	FOR ILLUSTRATIVE PURPOSES ONLY	DOME NTS CEROSED CROSED CROSED CROSED CROSED	OYSTER REEF DETAIL	EXAMPLE LIVING SHORELINE REEF PROJECT	DATE SEPTEMBER 2022 PROJECT NUMBER DRAWING CD-02 SHEET NUMBER 5 OF 5
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